

**PHILIPPINE  
PORTS  
AUTHORITY**



**PORT MANAGEMENT OFFICE - MARINDUQUE/QUEZON**

**CONSTRUCTION DRAWINGS**


**MAINTENANCE OF  
TMO BUILDING**

**PORT OF BALANACAN**

**MOGPOG, MARINDUQUE**




VICINITY MAP  
NOT TO SCALE

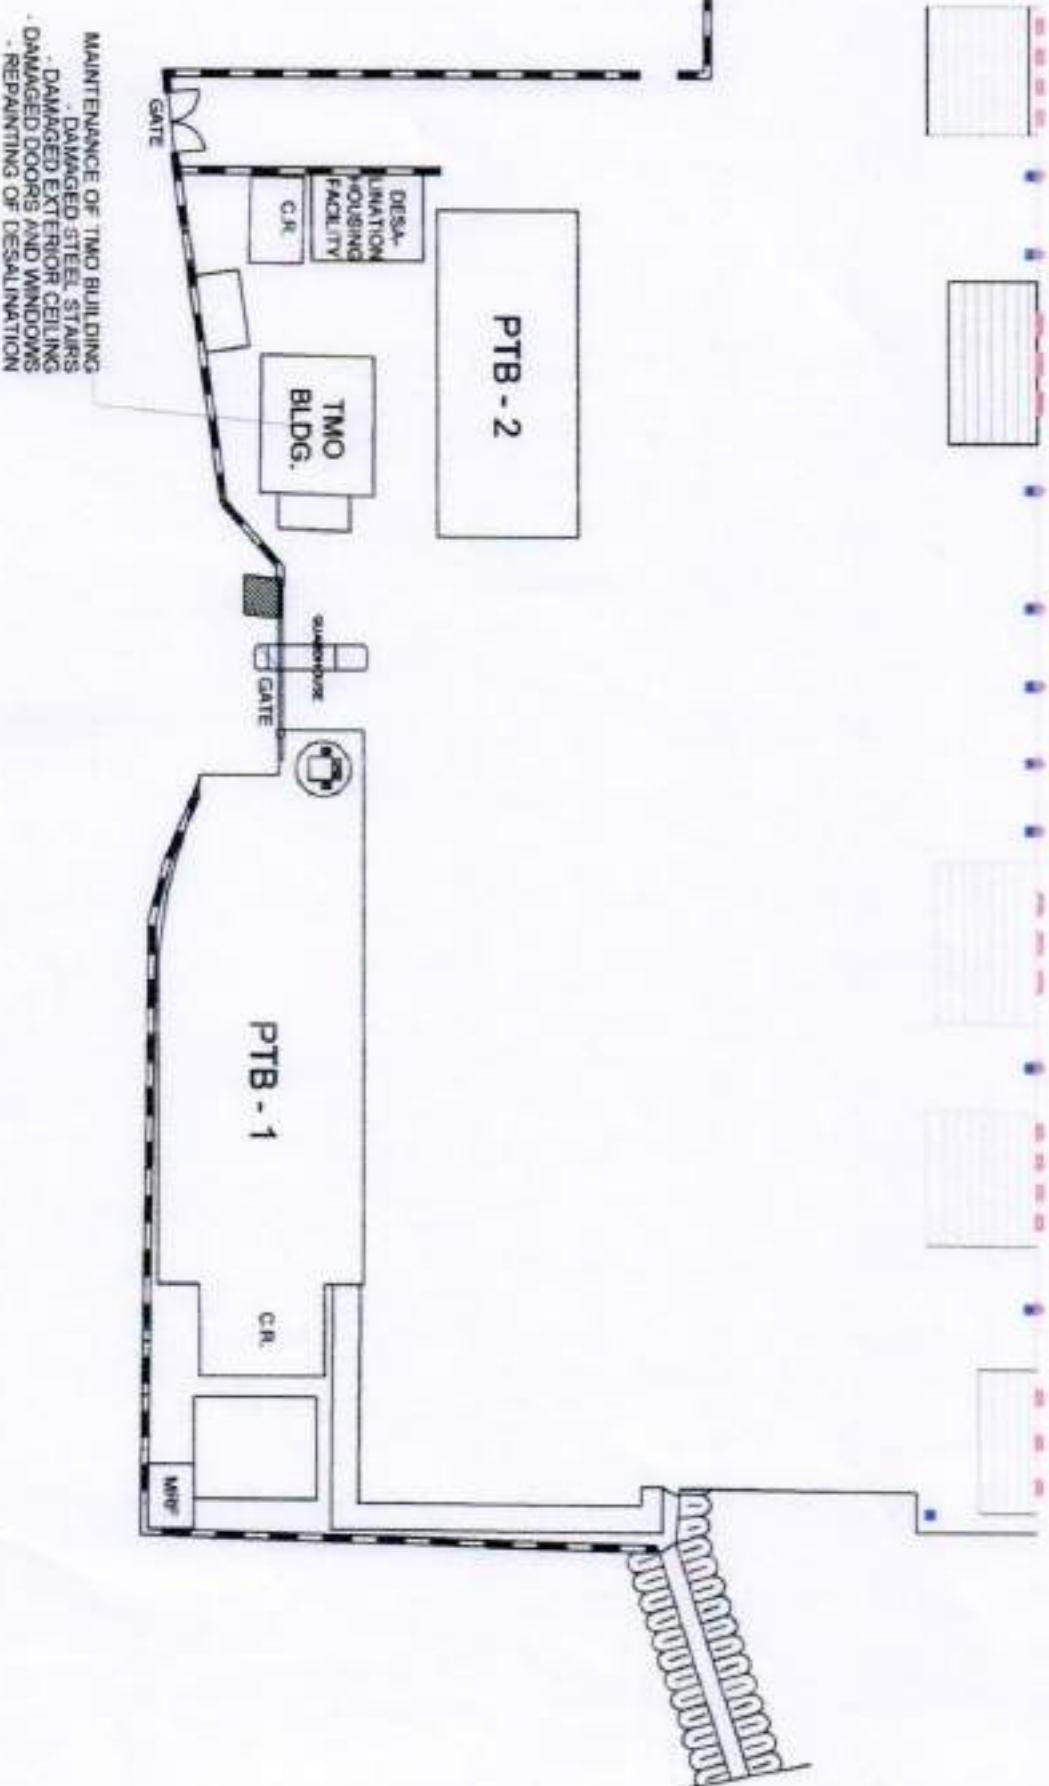

<p>PHILIPPINE PORTS AUTHORITY</p> <p>PORT MANAGEMENT OFFICE - MAROUZ</p>	<p>PROJECT LOCATION:</p> <p><b>MAINTENANCE OF TMO BUILDING</b></p> <p>PORT OF BALABACAN</p> <p>MOGPOG, MAROUZ</p>	<p>PREPARED BY:</p> <p>MARK ANDREW S. Pineda SENIOR ENGINEER A</p>	<p>REVIEWED/RECOMMENDING APPROVAL:</p> <p>RAUL A. LIBATIQUE ACTING ESTIMATOR</p>	<p>APPROVED:</p> <p>FARUELIGO B. FORTAJADA PORT MANAGER</p>	<p>SHEET CONTENTS</p> <p>• DEVELOPMENT PLAN</p>	<p>SHEET NO.</p> <p>1 / 6</p>
--	---	--	--	---	---	-------------------------------



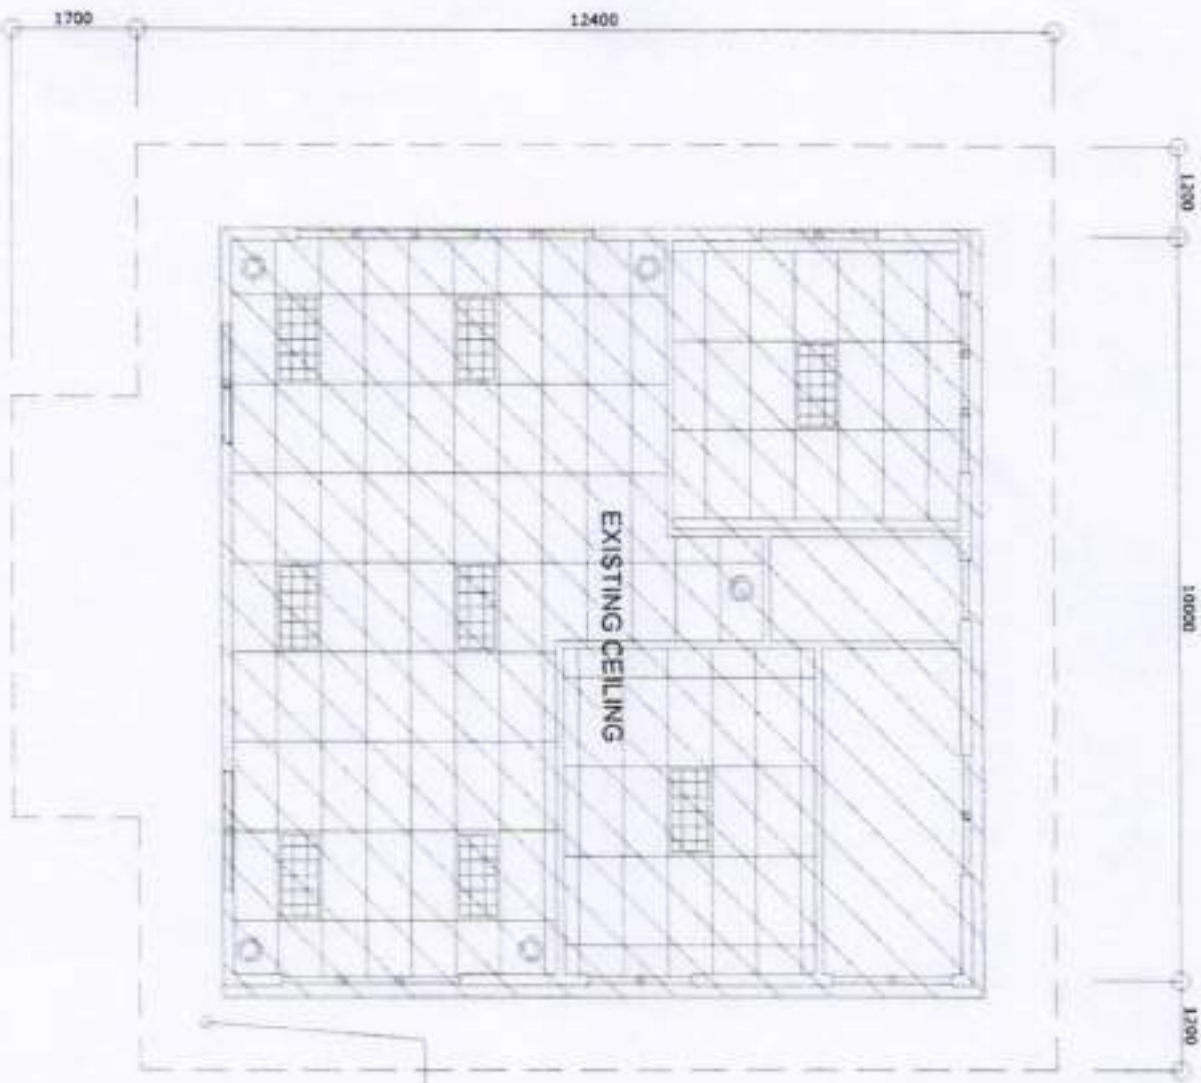


REPAIR OF DAMAGED EXTERIOR CEILING GUTTER, FASCIA BOARD AND DOWNSPOUT USE:

- 4" WIDTH SPANDREL CEILING AND METAL FURRING @ 0.60M SPACING O.C.
- 1" x 10" FASCIA BOARD
- STAINLESS SPANISH GUTTER

REPAIR OF DAMAGED EXTERIOR CEILING USE:

- 4" WIDTH SPANDREL CEILING AND METAL FURRING @ 0.60M SPACING O.C.

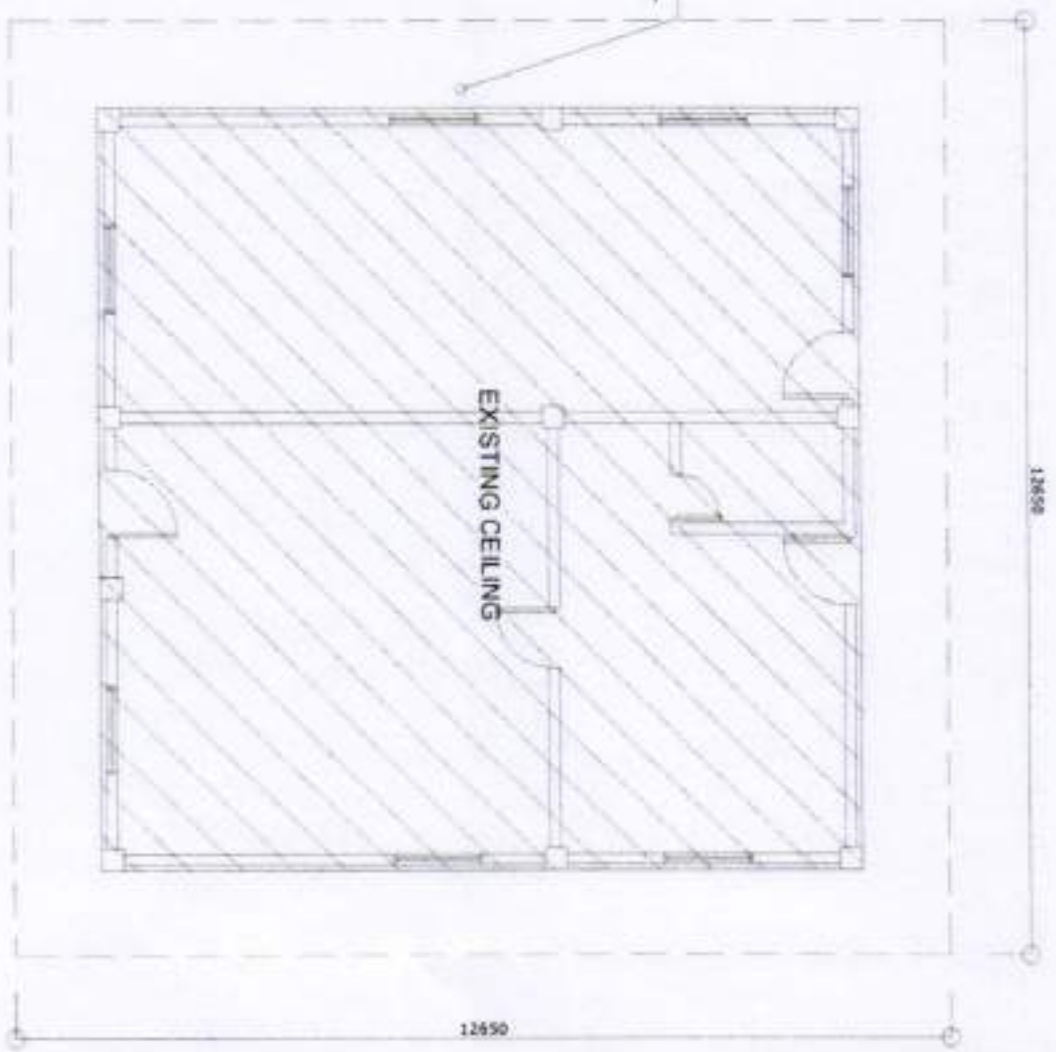


**G/F REFLECTED CEILING PLAN (TMO)**  
SCALE 1:100

**2/F REFLECTED CEILING PLAN (TMO)**  
SCALE 1:100

<p>PHILIPPINE PORTS AUTHORITY</p>  <p>PORT MANAGEMENT OFFICE - MARQUEZ</p>	<p>PROJECT/LOCATION:</p> <p><b>MAINTENANCE OF TMO BUILDING</b></p> <p>PORT OF BALANACAN MOGPOG, MARINUQUE</p>	<p>PREPARED BY:</p> <p> MARK ANDREW S. PINEDA SENIOR ENGINEER A</p>	<p>REVIEWED/RECOMMENDING APPROVAL:</p> <p> RAUL A. LIBATIQUE ACTING ISD MANAGER</p>	<p>APPROVED:</p> <p> FELIXIO P. PORTAJADA PORT MANAGER</p>	<p>SHEET CONTENTS</p> <ul style="list-style-type: none"> <li>• G/F REFLECTED CEILING PLAN (TMO)</li> <li>• 2/F REFLECTED CEILING PLAN (TMO)</li> </ul>	<p>SHEET NO.</p> <p><b>2 / 6</b></p>
---	---	--	--	---	--	--------------------------------------



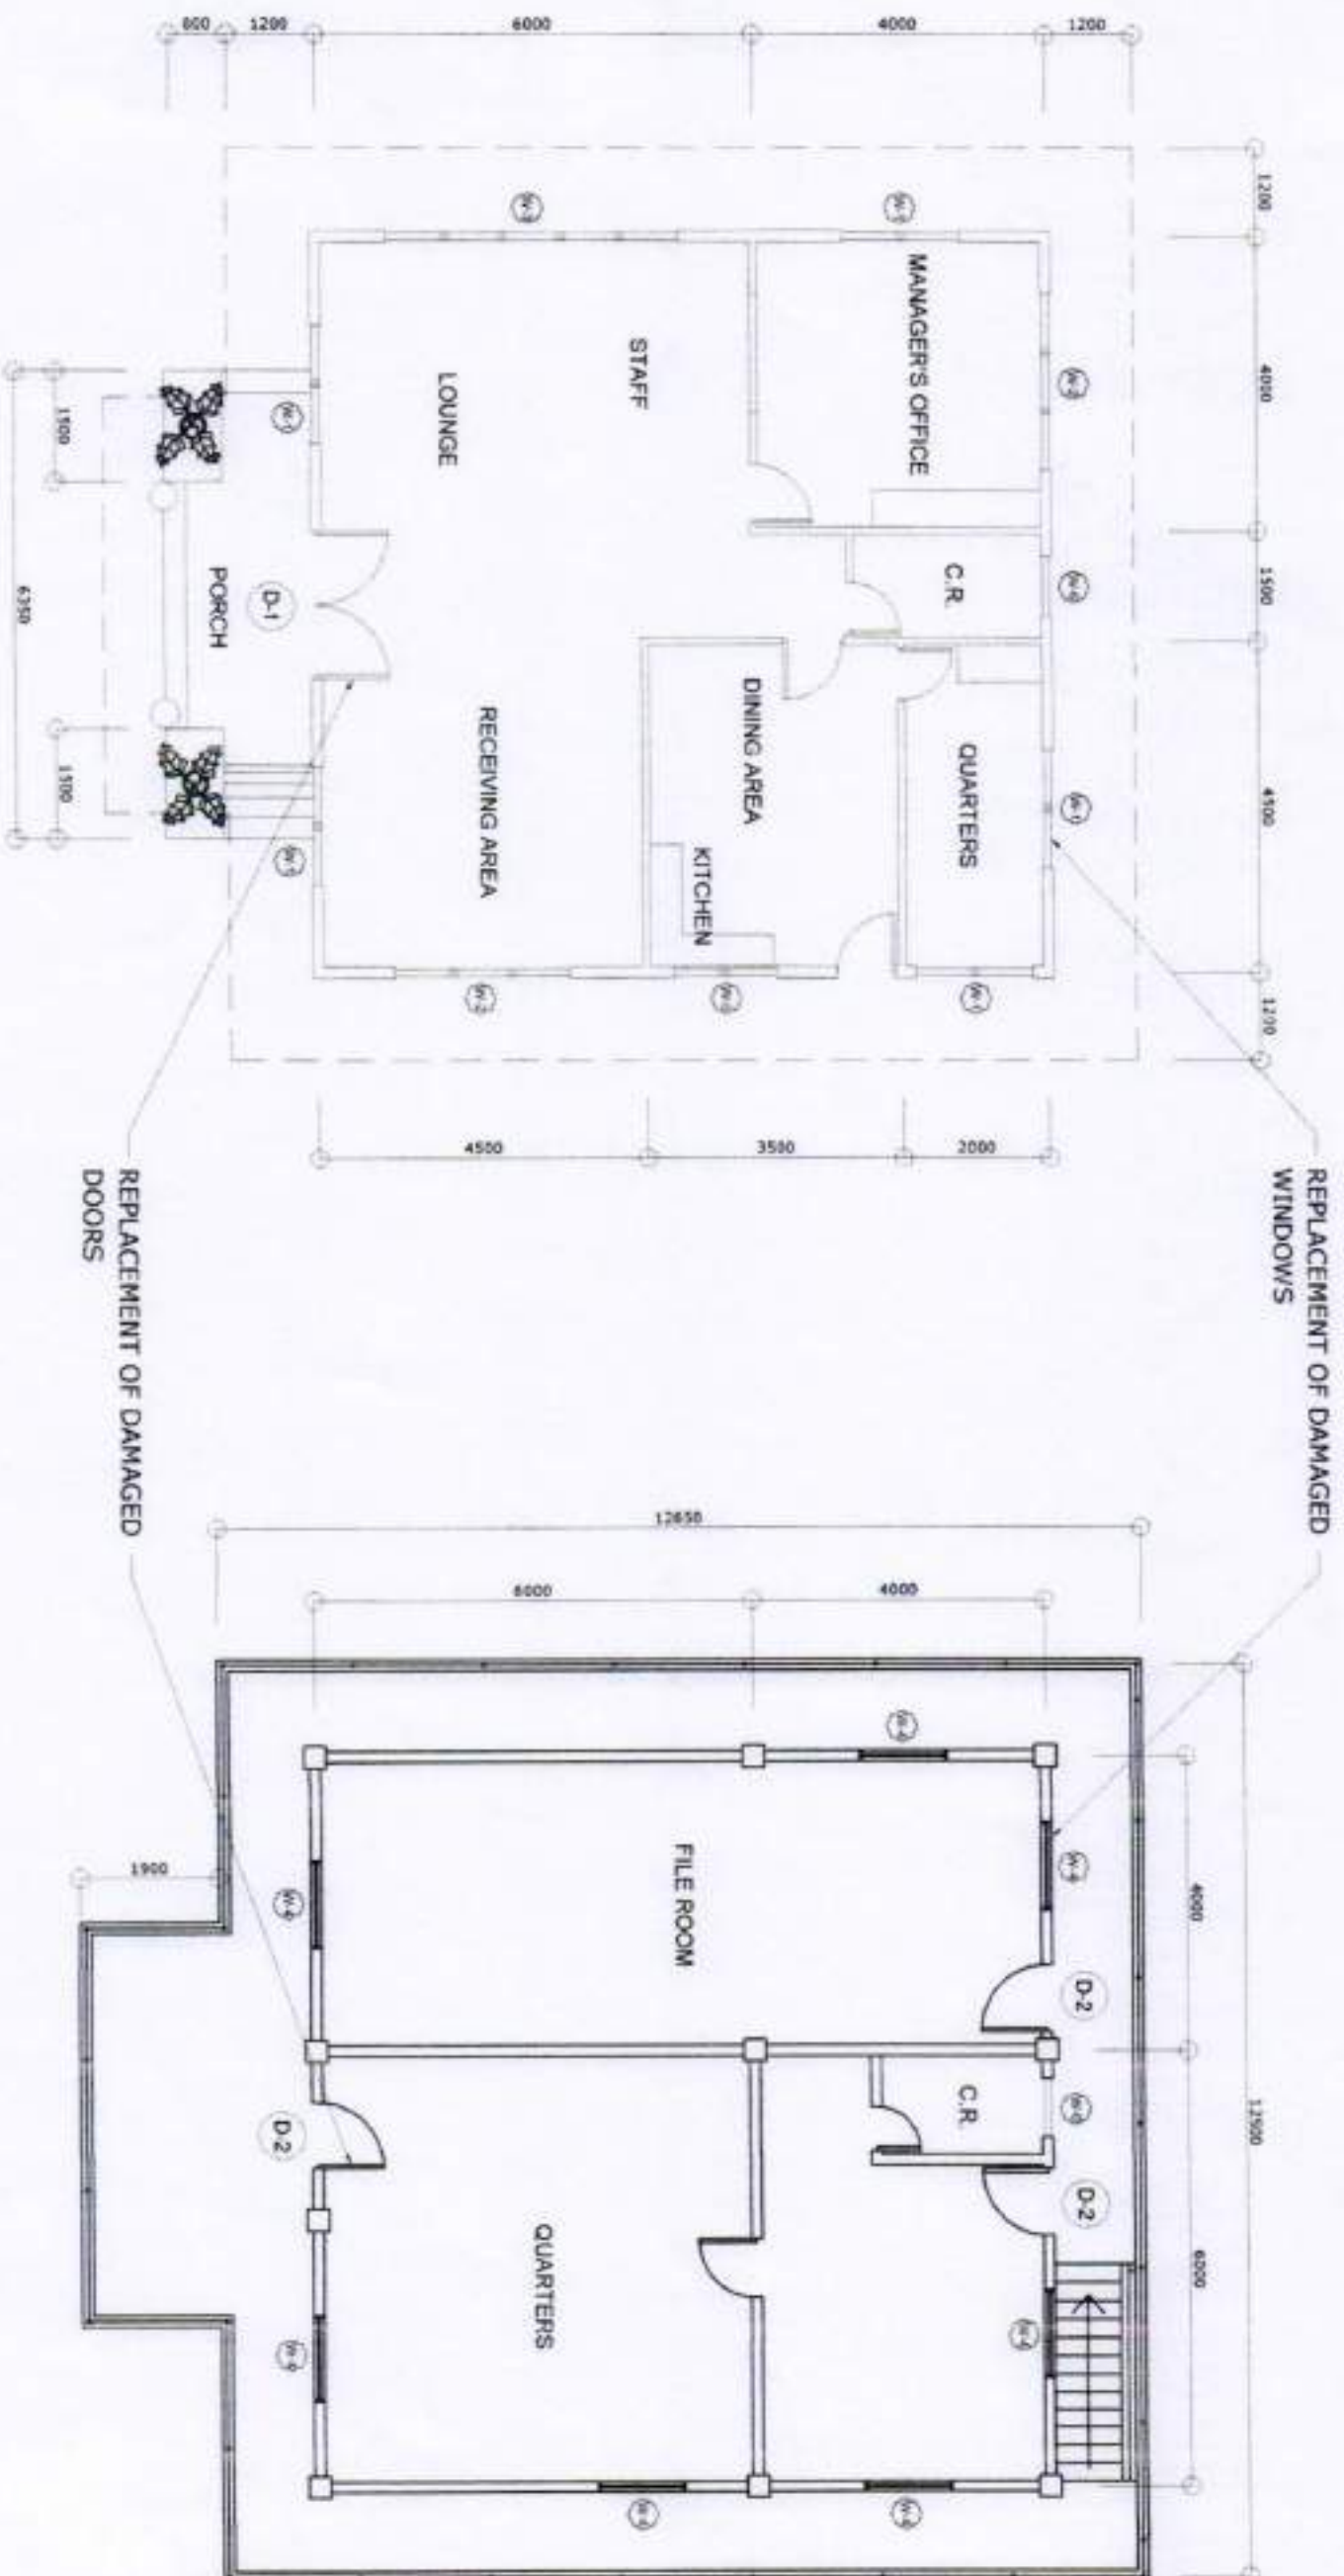


**GROUND FLOOR PLAN (TMO)**  
SCALE 1:100

**SECOND FLOOR PLAN (TMO)**  
SCALE 1:100

<p>PHILIPPINE PORTS AUTHORITY</p> <p>PORT MANAGEMENT OFFICE - MARQUEZ</p>	<p>PROJECT/LOCATION:</p> <p><b>MAINTENANCE OF TMO BUILDING</b></p> <p>PORT OF BALANACAN MOGPOG, MARINOUQUE</p>	<p>PREPARED BY:</p> <p>MARK ANDREW S. PINEDA SENIOR ENGINEER A</p>	<p>REVIEWED/RECOMMENDING APPROVAL:</p> <p>RAUL A. LIBATIQUE ACTING ESD MANAGER</p>	<p>APPROVED:</p> <p>FRANCIS ELIGOR P. PORTAJADA PORT MANAGER</p>	<p>SHEET CONTENTS</p> <ul style="list-style-type: none"> <li>● GROUND FLOOR PLAN (TMO)</li> <li>● SECOND FLOOR PLAN (TMO)</li> </ul> <p>SHEET NO.</p> <p><b>3 / 6</b></p>
---	--	--	--	--	---




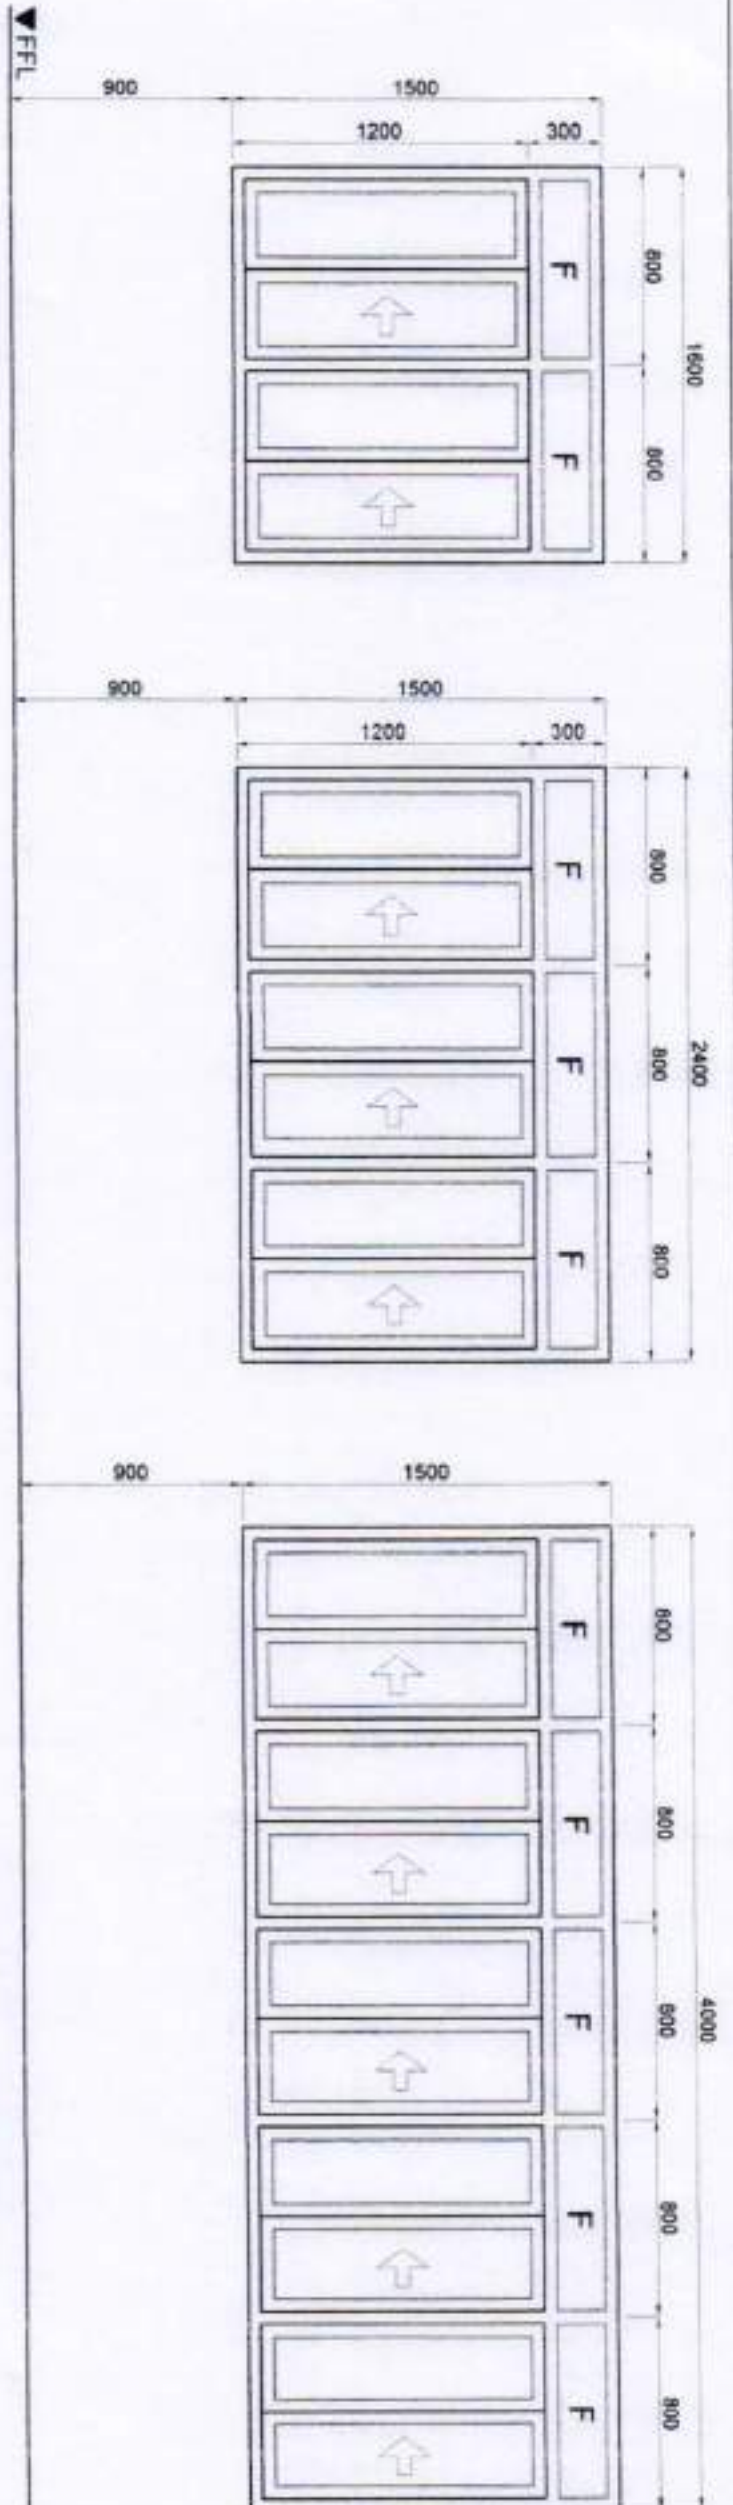

W-1 ALUMINUM FRAMED SLIDING TYPE WINDOW - POWDER COATED SETS REQUIRED - FIVE (5)

W-2 ALUMINUM FRAMED SLIDING TYPE WINDOW - POWDER COATED SETS REQUIRED - TWO (2)

W-3 ALUMINUM FRAMED SLIDING TYPE WINDOW - POWDER COATED SETS REQUIRED - ONE (1)

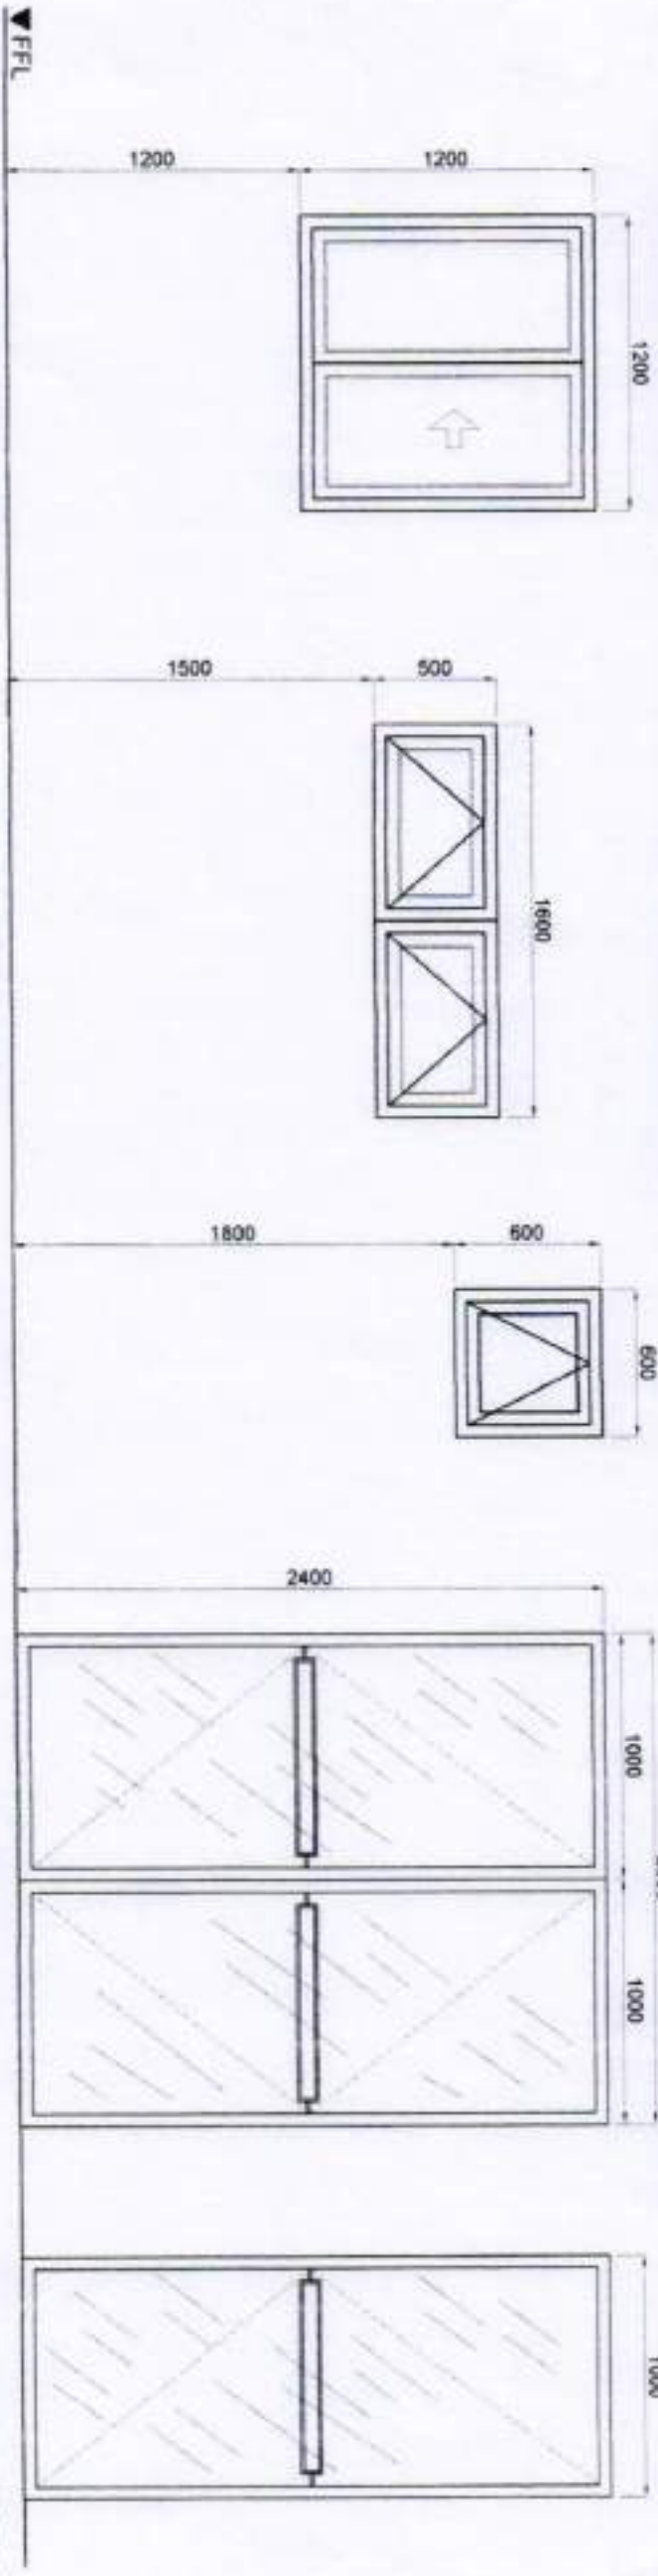

W-4 ALUMINUM FRAMED SLIDING TYPE WINDOW - POWDER COATED SETS REQUIRED - SEVEN (7)

W-5 ALUMINUM FRAMED AWNING TYPE WINDOW - POWDER COATED SETS REQUIRED - ONE (1)

W-6 ALUMINUM FRAMED AWNING TYPE WINDOW - POWDER COATED SETS REQUIRED - TWO (2)

D-1 ALUMINUM FRAMED SWING TYPE DOOR - POWDER COATED SETS REQUIRED - ONE (1)

D-2 ALUMINUM FRAMED SWING TYPE DOOR - POWDER COATED SETS REQUIRED - THREE (3)

# NOTE:

1. ALL DOORS AND WINDOWS USE 10mm THK. REFLECTIVE TEMPERED BROWN GLASS
2. ALUMINUM FRAME FOR DOORS & WINDOWS USE 50mm x 100mm x 1.5mm THK POWDER COATED

## SCHEDULE OF DOORS AND WINDOWS (TMO)




1:30

<p>PHILIPPINE PORTS AUTHORITY</p> <p>PORT MANAGEMENT OFFICE - MARQUEZ</p>	<p>PROJECT/LOCATION:</p> <p>MAINTENANCE OF TMO BUILDING</p> <p>PORT OF BALANACAN</p> <p>MOGPOG, MARINOUQUE</p>	<p>PREPARED BY:</p> <p>MARK ANDREW S. PINEDA</p> <p>SENIOR ENGINEER A</p>	<p>REVIEWED/RECOMMENDING APPROVAL:</p> <p>RAUL A. LIBATTOUE</p> <p>ACTING ESD MANAGER</p>	<p>APPROVED:</p> <p>FOR: ELIJO D. FORTIADA</p> <p>PORT MANAGER</p>	<p>SHEET CONTENTS</p> <p>SCHEDULE OF DOORS AND WINDOWS (TMO)</p> <p>4 / 6</p>	<p>SHEET NO.</p>
---	--	---	---	--	---	------------------







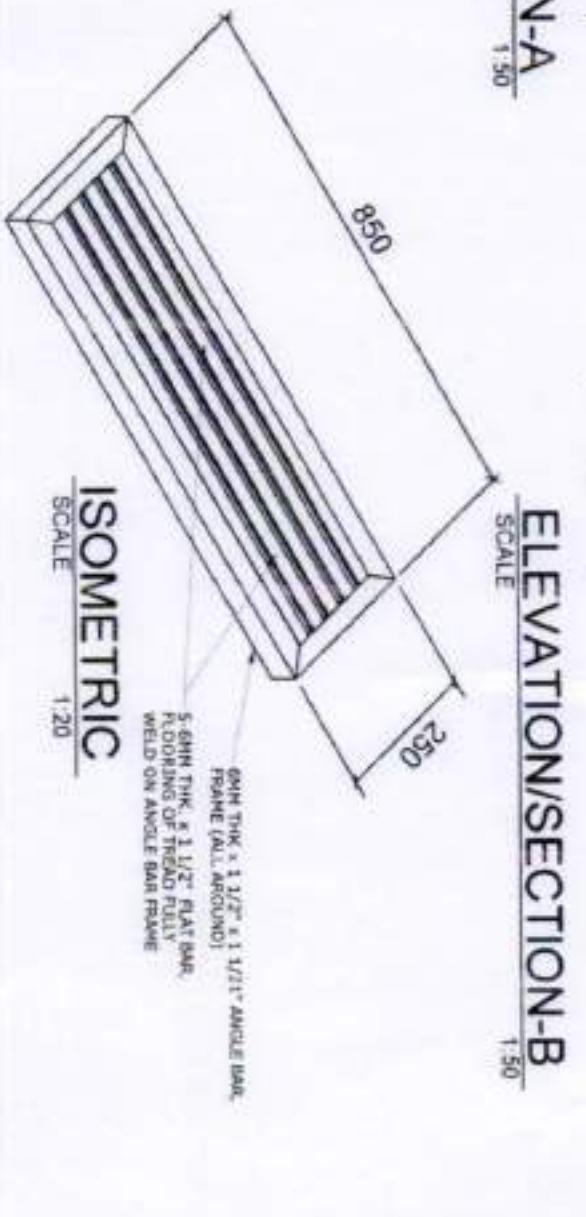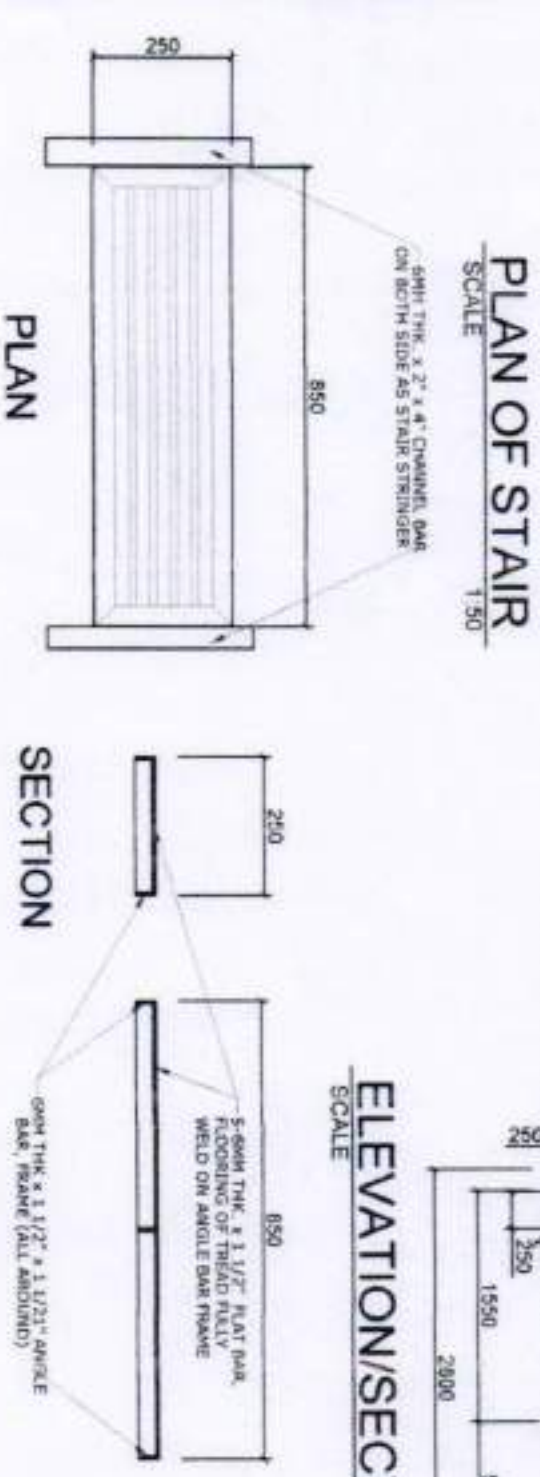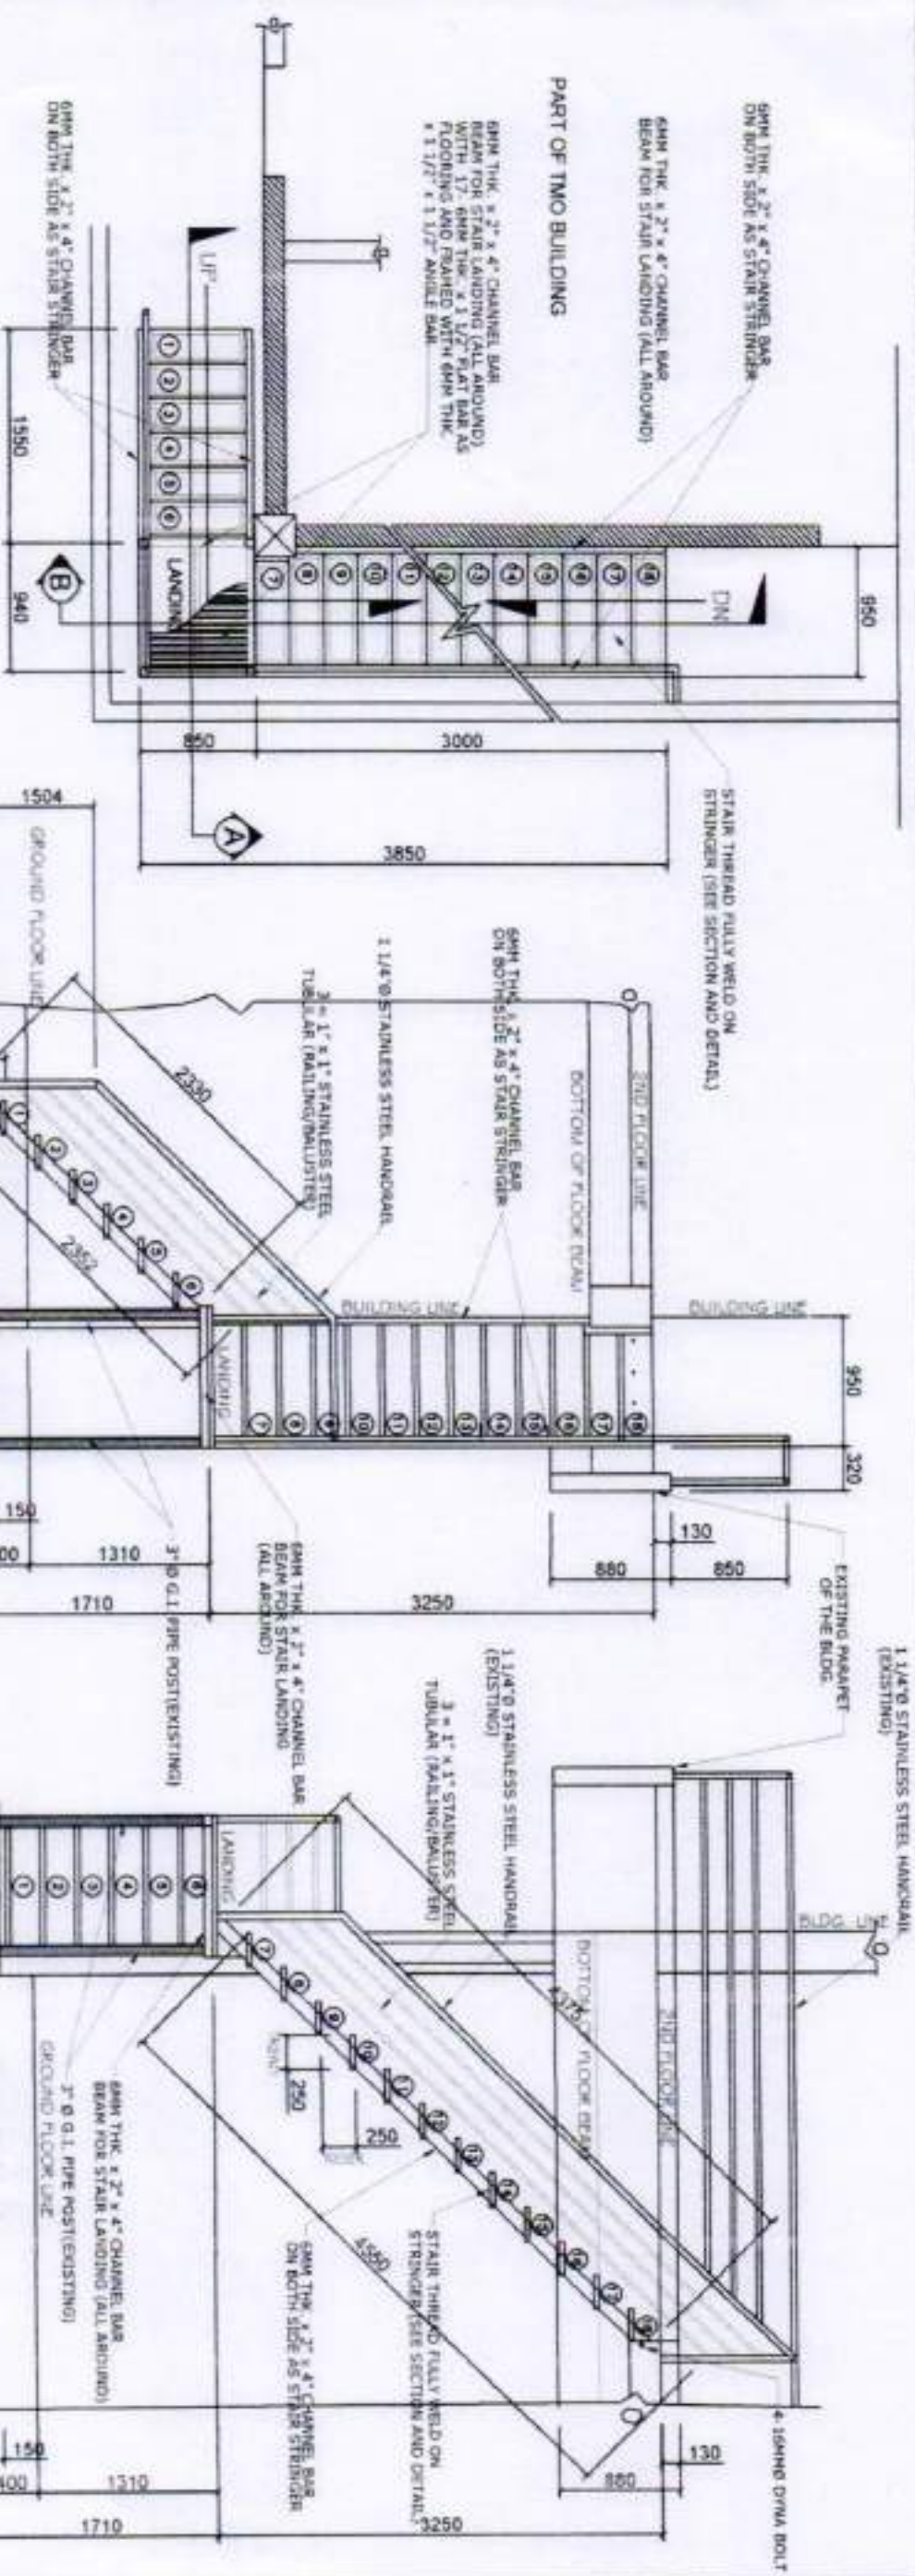

**PLAN/SECTION/DETAIL OF STAIR TREAD**  
SCALE 1:20

<p>PHILIPPINE PORTS AUTHORITY</p> <p>PORT MANAGEMENT OFFICE - MARQUEZ</p>	<p>PROJECT/LOCATION:</p> <p><b>MAINTENANCE OF TMO BUILDING</b></p> <p>PORT OF BALANACAN</p> <p>MOCPOG, MARINAUQUE</p>	<p>PREPARED BY:</p> <p>MARK ANDREW S. PINEDA SENIOR ENGINEER A</p>	<p>REVIEWED/RECOMMENDING APPROVAL:</p> <p>RAUL A. LIBATIQUE ACTING ESD MANAGER</p>	<p>APPROVED:</p> <p>For ELIOP P. FORTAJADA PORT MANAGER</p>	<p>SHEET CONTENTS</p> <p>SECTION/DETAIL OF STAIR TREAD</p> <p><b>6 / 6</b></p>
---	---	--	--	---	--