


THIS SITE

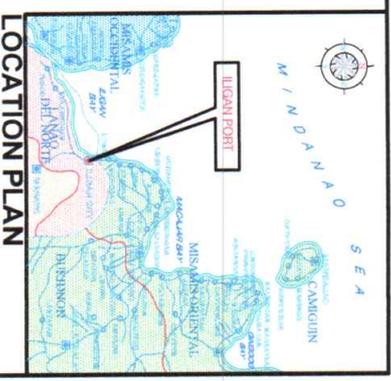

VICINITY PLAN
SCALE

REVISION

TITLE: **REPAIR OF PUBLIC RESTROOMS AT NEW PICO BUILDING**

ARCHITECTURAL

SHEET NO.

LOCATION: **PORT OF ILIGAN, ILIGAN CITY**

PREPARED BY: **ARNEL C. OOLARINO**
Signed
Senior Engineer A

CHECKED BY: **COLIN KAY R. CAJOTE**
Signed
Supervising Engineer/Acting Principal Engineer A


RECOMMENDED BY: **JOEL B. ESCALA**
Signed
ESD Manager

APPROVED: **MEDARDO I. SOSOBRAO, JR.**
Signed
Acting Port Manager


- LOCATION PLAN
- VICINITY PLAN

1
7



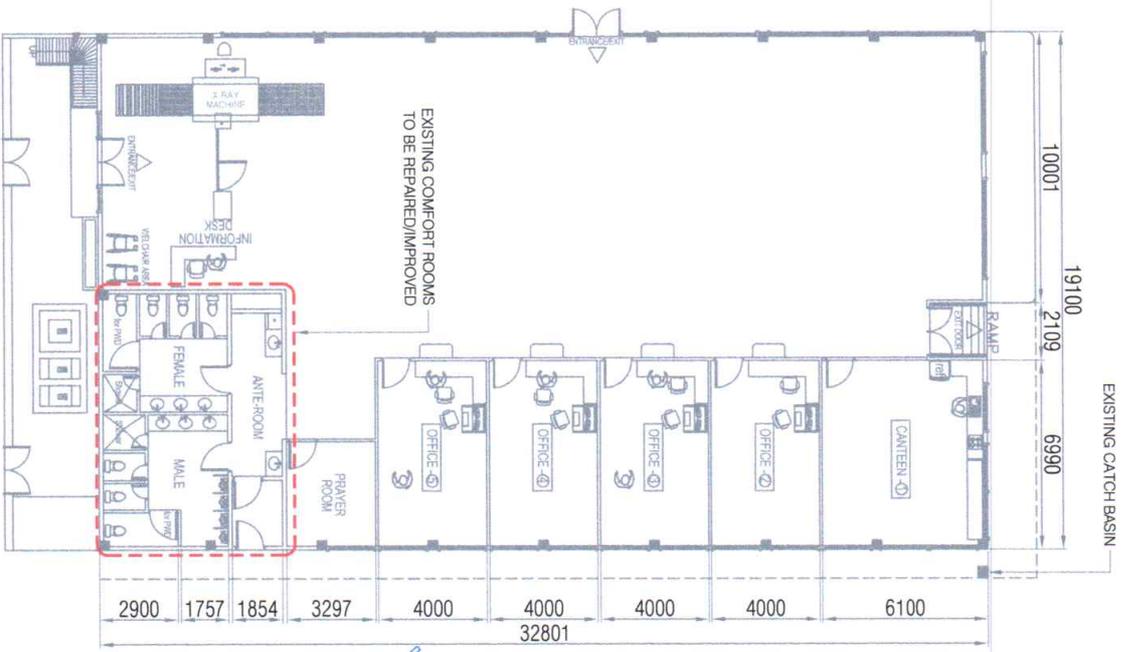




SITE DEVELOPMENT PLAN
SCALE 1:200M/TS

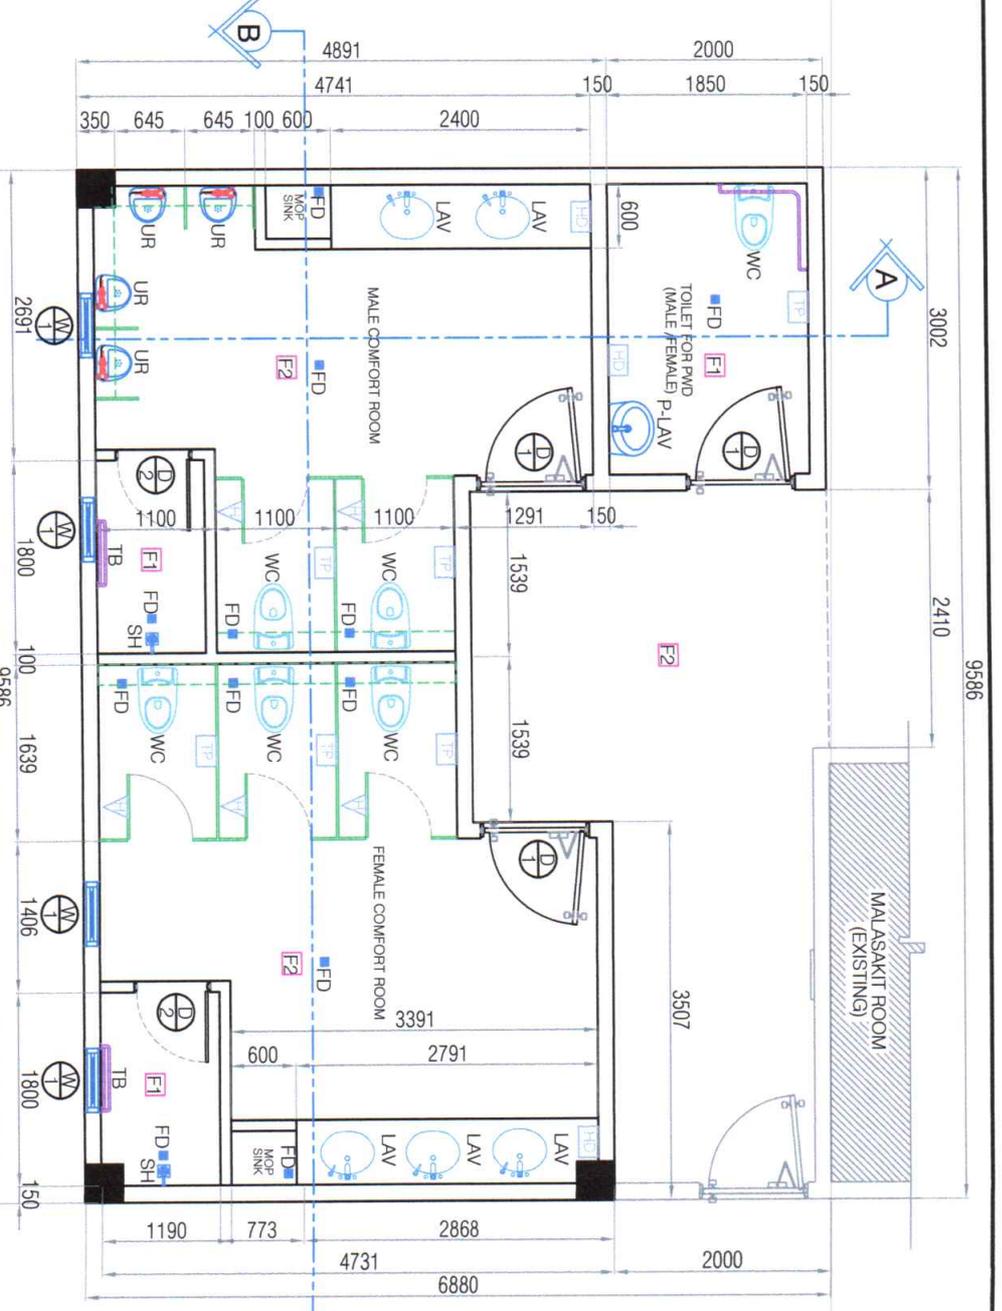

- LEGEND:**
- F1 - 300 X 300MM NON-SKID CERAMIC FLOOR TILES
 - F2 - 600 X 600MM UNGLAZED FLOOR TILES
 - F3 - 600 X 600MM GLAZED WALL TILES
 - P-LAV - PEDESTAL LAVATORY
 - LAV - COUNTER TOP LAVATORY
 - UR - URINAL (WASH-DOWN)
 - FD - FLOOR DRAIN (100MMX100MM STAINLESS)
 - PMD - PERSON WITH DISABILITY (PWD)
- NOTE:**
- * ELEVATE R.C. FLOORING FLUSHED LEVEL TO EXISTING
 - COAT/BAG HANGER (HOOK SHALL BEAR AT LEAST 7 KGS. - STAINLESS STEEL)
 - HAND DRYER (HEAVY DUTY WALL-MOUNTED)
 - CUBICLE LEDGE
 - URINAL LEDGE
 - URINAL WASH-DOWN
 - COUNTER TOP LAVATORY
 - PEDESTAL LAVATORY
 - WATER CLOSET (ELONGATED, SINGLE FLUSH w/ BIDET HOSE)

COMFORT ROOM REPAIR PLAN
SCALE 1:50M/TS

	REVISION	TITLE:	REPAIR OF PUBLIC RESTROOMS AT NEW PICO BUILDING		ARCHITECTURAL	
	LOCATION: PORT OF ILAGAN, ILAGAN CITY	PREPARED BY: ARNEL C. OOLARINO Senior Engineer A	CHECKED BY: COLIN KAY R. CAJOTE Supervising Engineer/Chief Principal Engineer A	RECOMMENDED BY: JOEL B. ESCALA ESD Manager	APPROVED: MEDARDO I. SOSOBRAO, JR. Acting Port Manager	

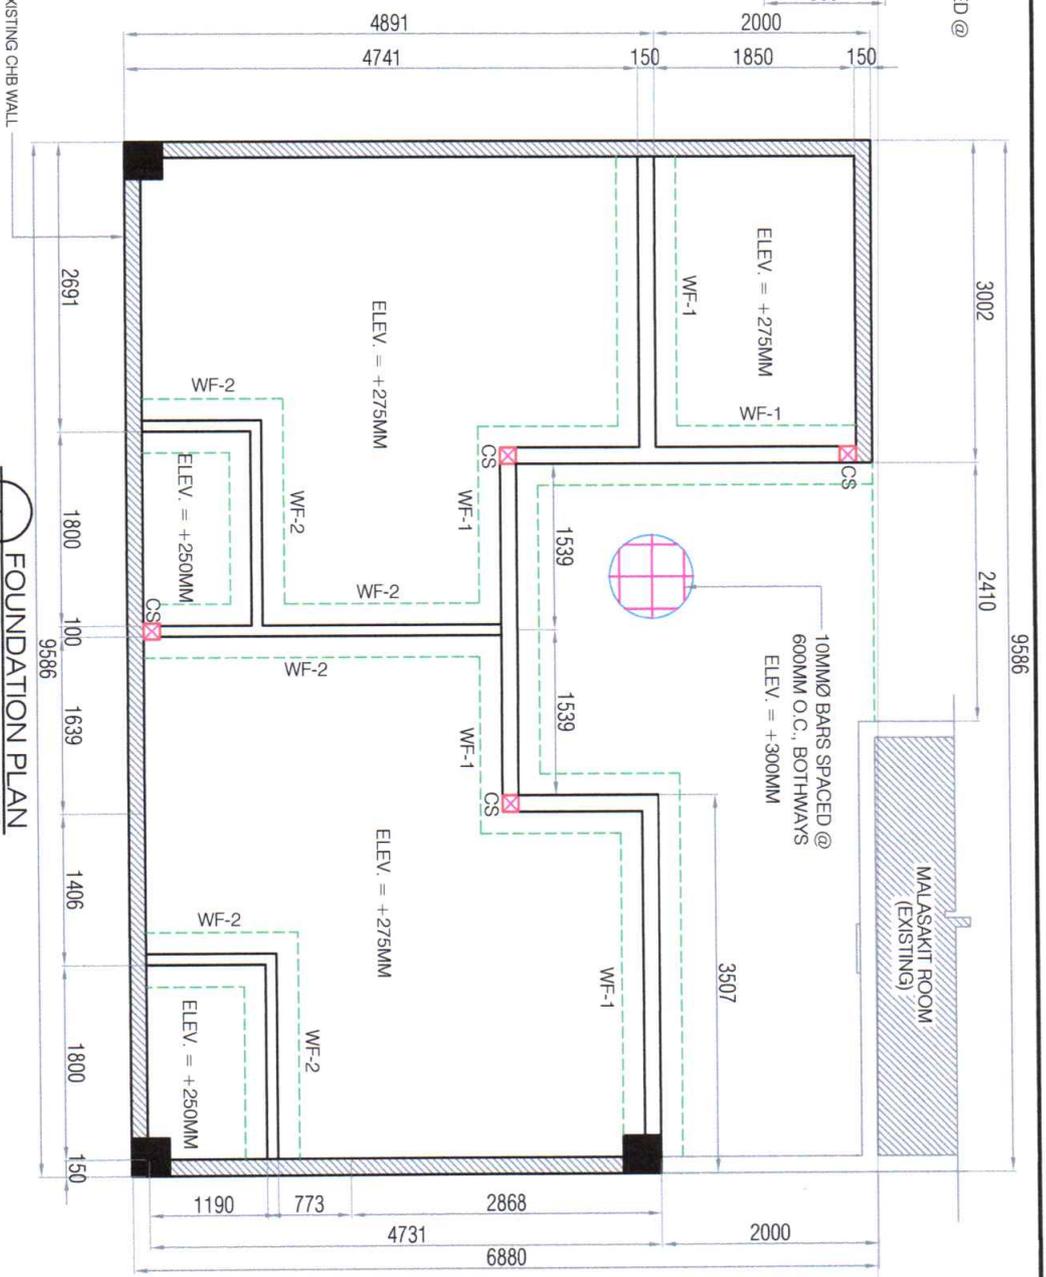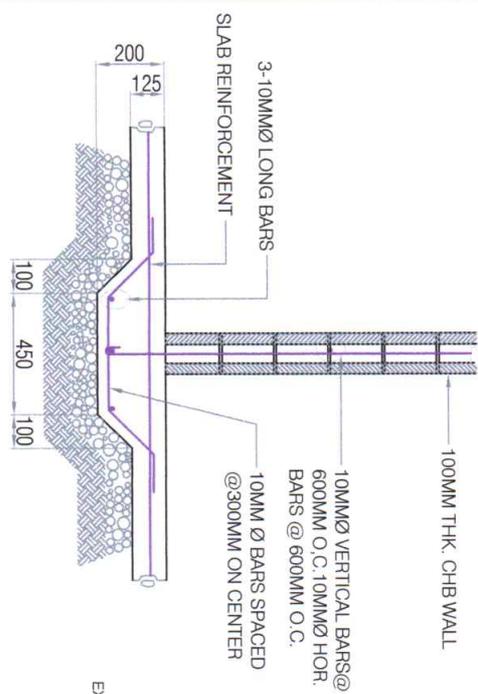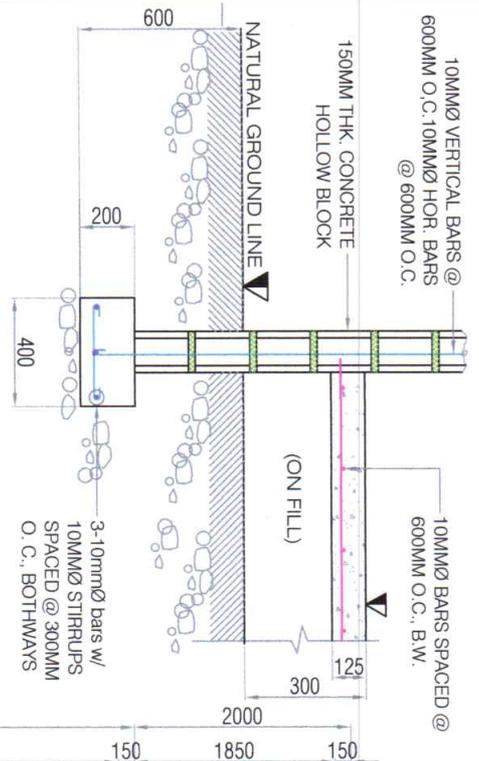

REPAIR OF PUBLIC RESTROOMS AT NEW PICO BUILDING

	REVISION	TITLE:	PORT OF ILAGAN, ILAGAN CITY			ARCHITECTURAL	
	PREPARED BY: ARNEL C. OCAARINO <small>Senior Engineer A</small>	CHECKED BY: COLIN KAY R. CAJOTE <small>Supervising Engineer / Asst. Principal Engineer A</small>	RECOMMENDED BY: JOEL B. ESCALA <small>ESD Manager</small>	APPROVED: MEDARDO L. SOSOBRAO, JR. <small>Acting Port Manager</small>	SHEET CONTENTS ● FOUNDATION PLAN ● TYP. DET. OF COLUMN STIFFENER ● DETAIL OF WALL FOOTING 1 ● DETAIL OF WALL FOOTING 2		




REVISION

TITLE: REPAIR OF PUBLIC RESTROOMS AT NEW PICO BUILDING	
LOCATION: PORT OF ILGAN, ILGAN CITY	CHECKED BY: <i>Signed</i> COLIN KAY R. CAJOTE Supervising Engineer - Admin, Principal Engineer - A
PREPARED BY: <i>Signed</i> ARNEL C. OCALARINO Senior Engineer - A	RECOMMENDED BY: <i>Signed</i> JOEL B. ESCALA ESD Manager
	APPROVED: <i>Signed</i> MEDARDO I. SOSORRADO, JR. Acting Port Manager


SHEET CONTENTS

- LINTEL BEAM LAYOUT/ REFLECTED CEILING PLAN
- TYPICAL DETAIL OF LINTEL BEAM (LB-1)

SHEET NO.
5/7

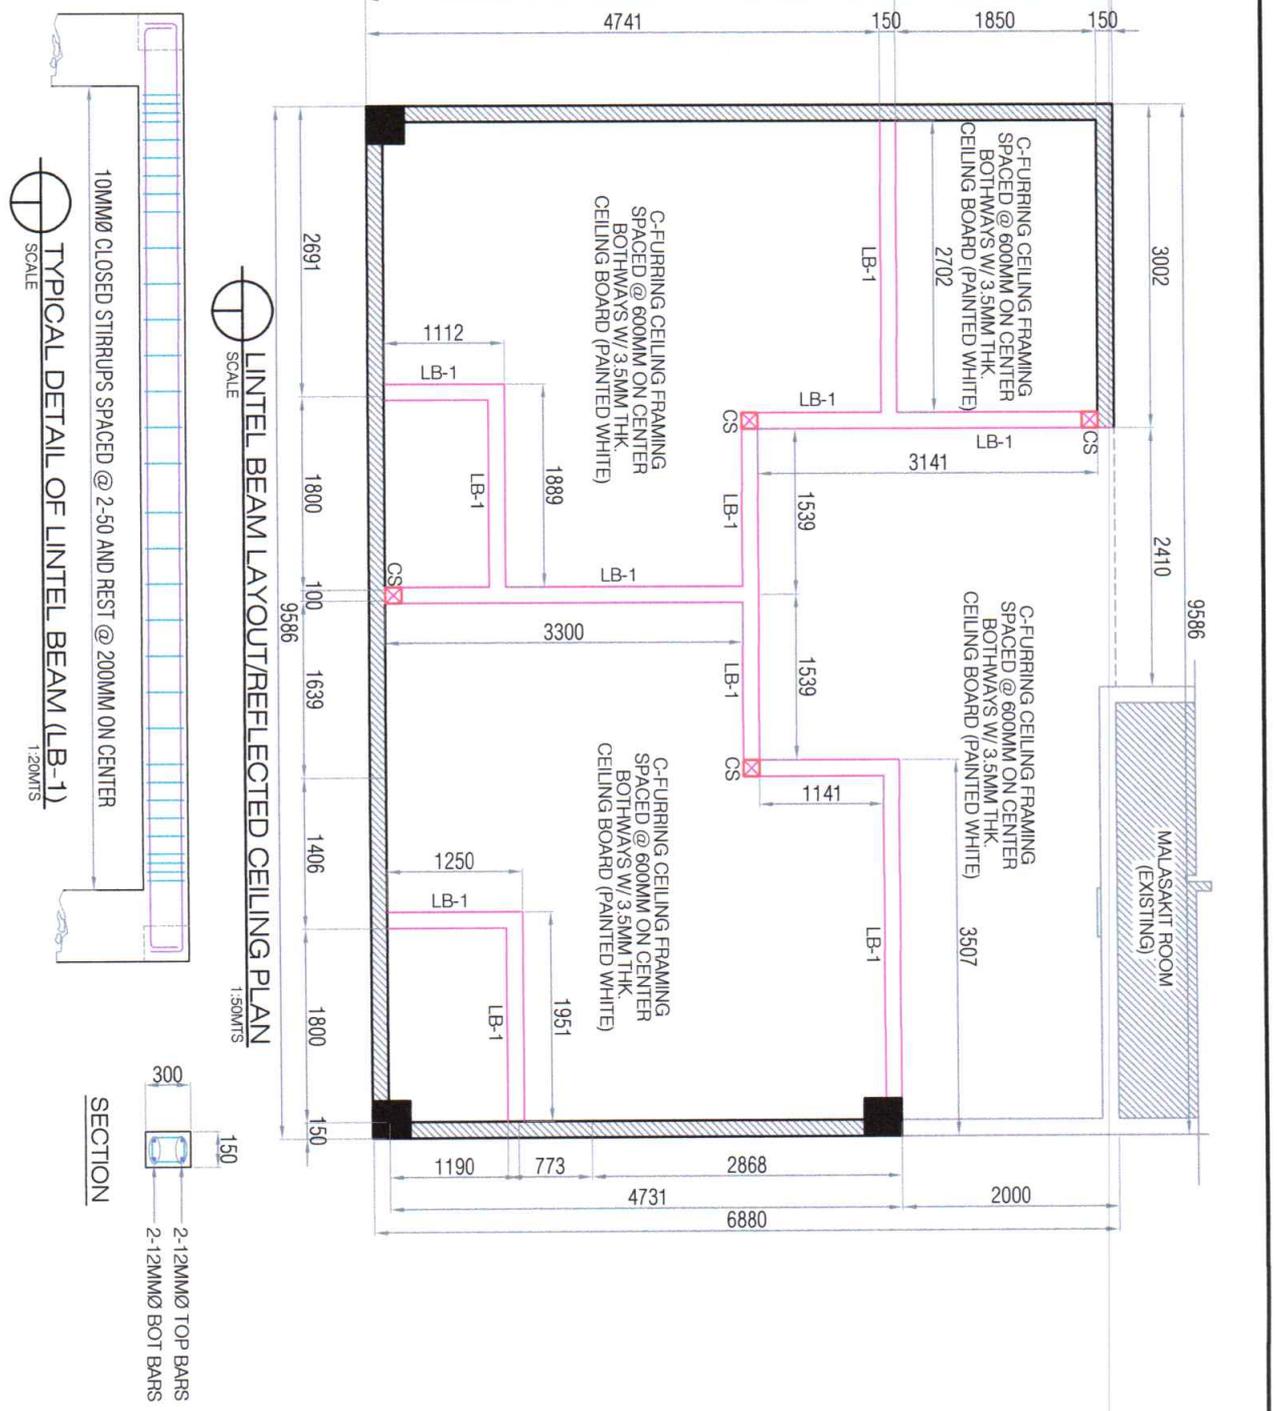

- GENERAL NOTES:**
1. ALL ELECTRICAL WORKS SHALL BE DONE IN ACCORDANCE WITH THE RULES & REGULATIONS OF THE LATEST PHILIPPINE ELECTRICAL CODE, NATIONAL AND LOCAL LAWS OF THE PHILS. GOVERNING ELECTRICAL PLANS AND INSTALLATION IN COMPLIANCE WITH THE REQUIREMENTS OF THE LOCAL POWER COMPANY.
 2. METHOD OF WIRING SHALL BE IN RIGID STEEL CONDUIT PIPE WITH PROPER FITTINGS, SUPPORTS & DEVICES, OTHERWISE INDICATED IN THE PLANS.
 3. ALL MATERIALS & EQUIPMENT SHALL BE OF THE APPROVED TYPE FOR THE LOCATION AND PURPOSE.
 4. CONVENIENCE OUTLET SHALL BE INSTALLED 0.30 M ABOVE FLOORLINE. METHOD OF WIRING SHALL BE IN PVC ELECTRICAL PIPE EMBEDDED IN CONCRETE WALLS.
 5. ALL ELECTRICAL WORKS SHALL BE DONE UNDER THE DIRECT SUPERVISION OF A DULY LICENSED ELECTRICAL ENGINEER OR MASTER ELECTRICIAN.
 6. LIGHTING SWITCHES - 1.4m ABOVE FLOOR FINISH
 7. CONVENIENCE OUTLETS - 0.3m ABOVE FLOOR FINISH OR AS REQUIRED
 8. PANELBOARDS & CABINETS - 1.8m ABOVE FLOOR FINISH AT TOP OR AS REQUIRED

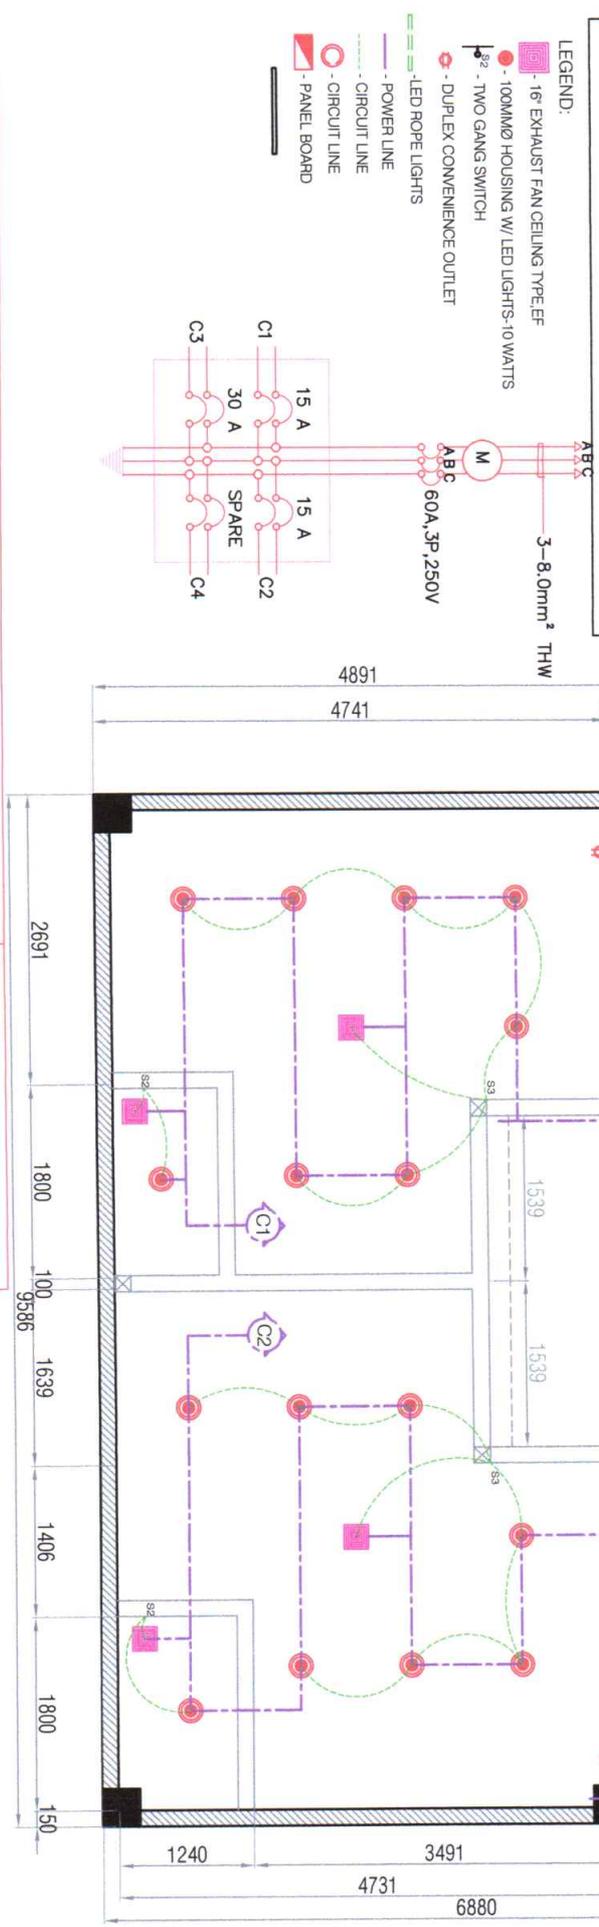

SCHEDULE OF LOADS

CKT. NO.	LOAD DESCRIPTION	NO. OF OUTLETS	VOLTS	PHASE CURRENT			PROTECTION PER CIRCUIT	SIZES OF WIRES AND CONDUITS	COMPUTATION
				AB	BC	CA			
C1	LIGHTING OUTLET	12	220	8.82			15 A	THREE PHASE CURRENT = 1.732 X 8.91 Amperes = 15.45 Amperes	
C2	LIGHTING OUTLET	12	220		8.91		15 A		
C3	CONVENIENCE OUTLET	4	220			5.45	30 A		
C4	SPARE	220					30 A		
TOTAL		220	220	8.82	8.91	5.45	60 A		

SCALE
LIGHTING & POWER LAYOUT
1:50METS

REVISION

TITLE: **REPAIR OF PUBLIC RESTROOMS AT NEW PICO BUILDING**

ELECTRICAL

SHEET NO. **7**

LOCATION: **PORT OF ILLIGAN, ILLIGAN CITY**

RECOMMENDED BY: **JOEL B. ESCALA**

SHEET CONTENTS
● GENERAL NOTES & LEGEND
● LIGHTING & POWER LAYOUT



PREPARED BY: **ARNEL C. OCLARINO**

CHECKED BY: **COLINKAY R. CAOTE**

APPROVED: **MEDARDO I. SOSOBRAADO, JR.**

Acting Port Manager

Supervising Engineer A

Senior Engineer A